
## **GENERAL NOTES:**


- 1. THIS PRODUCT HAS BEEN TESTED, ANALYZED & APPROVED FOR DESIGN PRESSURES NOT TO EXCEED THOSE SHOWN IN THE "ALLOWABLE DESIGN PRESSURE TABLE(S)".
- 2. OPENINGS, BUCKING & BUCKING FASTENERS MUST BE PROPERLY DESIGNED & INSTALLED TO TRANSFER WIND LOADS TO THE STRUCTURE.
- 3. ALL HARDWARE & FASTENERS SHALL BE IN ACCORDANCE WITH THESE DRAWINGS & SHALL NOT VARY UNLESS SPECIFICALLY MENTIONED ON THE DRAWINGS. SPECIFIED ANCHOR EMBED TO BASE MATERIAL SHALL BE BEYOND WALL FINISH OR STUCCO.
- 4. THIS PRODUCT HAS BEEN DESIGNED IN ACCORDANCE WITH AND MEETS THE REQUIREMENTS OF THE FLORIDA BUILDING CODE (FBC) INCLUDING HIGH VELOCITY HURRICANE ZONES (HVHZ) & IS LARGE MISSILE IMPACT RATED.
- 5. IMPACT SHUTTERS ARE NOT REQUIRED WITH THIS PRODUCT.
- 6. ALL ANCHORS SECURING PRODUCT FRAMES TO PRESSURE TREATED BUCKS OR WOOD FRAMING SHALL BE CAPABLE OF RESISTING CORROSION CAUSED BY THE PRESSURE TREATING CHEMICALS IN THE WOOD.
- 7. DETERMINE THE POSITIVE & NEGATIVE DESIGN LOADS TO USE WHEN REFERENCING THESE DOCUMENTS IN ACCORDANCE WITH THE GOVERNING CODE AND GOVERNING WIND VELOCITY. FOR WIND LOAD CALCULATIONS IN ACCORDANCE WITH THE FLORIDA BUILDING CODE, A DIRECTIONALITY FACTOR OF Kd = 0.85 MAY BE APPLIED PER THE ASCE-7 STANDARD.
- 8. MATERIALS, INCLUDING BUT NOT LIMITED TO STEEL SCREWS, THAT COME INTO CONTACT WITH OTHER DISSIMILAR MATERIALS SHALL MEET THE REQUIREMENTS OF FLORIDA BUILDING CODE.
- 9. TO THE BEST OF OUR KNOWLEDGE, THE PRODUCT SHOWN HEREIN IS QUALITY ASSURED BY A FLORIDA STATE APPROVED CERTIFICATION/QA ENTITY & SHALL BE LABELED IN ACCORDANCE WITH THE FBC AND THE FLORIDA DEPARTMENT OF BUSINESS & PROFESSIONAL REGULATION SPECIFICATIONS. THESE DRAWINGS SHOW ALL APPLICABLE ELEVATION, COMBINATION, INSTALLATION & COMPARATIVE ANALYSIS CONDITIONS AS DETERMINED THROUGH TESTING & ENGINEERING RATIONAL ANALYSIS. PRODUCT ASSEMBLY SHALL BE IN ACCORDANCE WITH THESE DRAWINGS, THE MANUFACTURER'S QUALITY ASSURANCE SPECIFICATIONS & TESTING REPORTS.
- 10. CERTIFICATION OF THIS PRODUCT SHALL BE CONSIDERED VOID IF IT IS INSTALLED WITHOUT A BUILDING PERMIT FROM THE APPLICABLE LOCAL BUILDING DEPARTMENT OR IF IT IS INSTALLED BY ANYONE OTHER THAN A LICENSED CONTRACTOR EXPERIENCED WITH INSTALLATIONS OF THIS TYPE OF PRODUCT.
- 11. ALL WOOD MEMBERS OF THIS PRODUCT THAT MAY POSSIBLY COME INTO CONTACT WITH MASONRY OR CONCRETE SUBSTRATES, ARE SUBJECT TO MOISTURE &/OR ARE SUBJECT TO THE OUTSIDE ENVIRONMENT SHALL BE OF AN APPROVED DURABLE SPECIES OR BE TREATED IN AN APPROVED METHOD WITH AN APPROVED PRESERVATIVE PER FBC REQUIREMENTS.


EVALUATION OF THIS PRODUCT IS BASED ON APPLICABLE STANDARDS AND/OR INFORMATION & RESULTS FROM APPLICABLE TEST REPORTS. THE FLORIDA BUILDING CODE VERSION CONSIDERED WITH THIS EVALUATION WAS THAT IN FORCE AT THE TIME OF THE EVALUATION. IN THE EVENT OF CODE VERSION CHANGES/UPDATES OR IN THE EVENT THAT NEW OR ADDITIONAL TESTING IS COMPLETED ON THIS PRODUCT, PRIOR TO STATING CODE COMPLIANCE WITH THE STATE, THE MANUFACTURER SHALL CONFIRM WITH THE EVALUATION ENGINEER OF RECORD THAT EVERYTHING SPECIFIED HERE—IN IS CURRENT WITH ALL CURRENT TESTING, CODES AND APPLICABLE STANDARDS

FRAME ANCHOR REQUIREMENTS TABLE							
OPENING TYPE (SUBSTRATE)	FRAME/HINGE/STRIKE/CLIP TO OPENING FASTENER TYPE		MINIMUM EDGE DIST.				
FRAME SCREWS							
MIN. 2X4 WOOD FRAME OR BUCK (MIN. GR. 3 & G=0.55)	NO. 10 SMS OR WOOD SCREW	1 1/4"	3/4"				
MIN. 18 GA. 33 KSI METAL STUD	NO. 10 GR. 5 SELF TAP/DRILL SCREW	FULL	1/2"				
MIN. 1/8" THK A36 STEEL	NO. 10 GR. 5 SELF TAP/DRILL SCREW	FULL	1/2"				
MIN. 1/8" THK 6063-T5 ALUM.	NO. 10 GR. 5 SELF TAP/DRILL SCREW	FULL	1/2"				
MIN. C-90 CMU	(1) 1/4" CONCRETE SCREW	1 1/4"	2"				
MIN. 2500 PSI CONCRETE	(1) 1/4" CONCRETE SCREW	1 1/2"	2"				
HINGE & STRIKE SCREWS							
MIN. 2X4 WOOD FRAME OR BUCK (MIN. GR. 3 & G=0.55)	NO. 10 SMS OR WOOD SCREW	1 1/4"	·3/4"				
MIN. 18 GA. 33 KSI METAL STUD	NO. 10 GR. 5 SELF TAP/DRILL SCREW	FULL	1/2"				
MIN. 1/8" THK A36 STEEL	NO. 10 GR. 5 SELF TAP/DRILL SCREW	FULL	1/2"				
MIN. 1/8" THK 6063-T5 ALUM.	NO. 10 GR. 5 SELF TAP/DRILL SCREW	FULL	1/2"				
MIN. C-90 CMU	(1) 3/16" CONCRETE SCREW	1 1/4"	2"				
MIN. 2500 PSI CONCRETE	(1) 3/16" CONCRETE SCREW	1 1/2"	2"				
INSTALLATION CLIP SCREWS							
MIN. 2X4 WOOD FRAME OR BUCK (MIN. GR. 3 & G=0.55)	NO. 8 SMS SCREW	1 3/8"	1/2"				
MIN. 18 GA. 33 KSI METAL STUD	NO. 8 GR. 5 SELF TAP/DRILL SCREW	FULL	1/2"				
MIN. 1/8" THK A36 STEEL	NO. 8 GR. 5 SELF TAP/DRILL SCREW	FULL	1/2"				
MIN. 1/8" THK 6063-T5 ALUM.	NO. 8 GR. 5 SELF TAP/DRILL SCREW	FULL	1/2"				
(1) CONCRETE SCREWS SHALL BE ELCO ULTRACONS (C.S.), ELCO CRETE-FLEX (S.S.), ITW RAMSET/RED HEAD TAPCONS (C.S. OR S.S.) OR HILTI KWIK-CON II (C.S OR S.S.).							

THESE DRAWINGS ARE APPLICABLE ONLY TO THE PRODUCT HECKED BY: SPECIFIED. THEY MAY NOT BE USED FOR THE ASSEMBLY W.W.S. AND/OR INSTALLATION OF ANY OTHER PRODUCT NOR MAY 06/13/13 THEY BE USED FOR RATIONAL AND/OR LOCAL APPROVAL OF ANY PRODUCT NOT PRODUCED BY THE MANUFACTURER – 74 7/8" MAX. FRAME WIDTH -STRIKE SCREWS INTO SUBSTRATE (3 PER STRIKE PLATE). SEE "FRAME ANCHOR REQUIREMENTS TABLE" ON THIS SHEET FOR SCREW REQUIREMENTS (HEAD & SILL) 6" MAX. − 6" MAX. 6" MAX. FRAME SCREWS NAIL FIN AND S N OR INSTALLATION ANCHORING OF NAIL STRIKE CLIPS WHERE FIN IS OPTIONAL & PLATE 69 SHOWN. SEE SHALL NOT ACT AS OPPOSITI OUTH 11TH AVE. O, WI 54401 -842-5666 A SUBSTITUTE FOR "FRAME ANCHOR (8)  $\left(\frac{8}{8}\right)$ 8 MILLWORK THE FRAME ANCHORS REQUIREMENTS SIDES) SPECIFIED. FIN MAY TABLE" ON THIS ACTIVE INACTIVE BE REMOVED WHEN SHEET FOR REQUIRED BY REQUIREMENTS. (AT OPENING CONDITIONS KOLBE ō -(65)(67)(68) HINGE SCREW INTO DOOR SUBSTRATE (2 PER HANDLE TOP & BOTTOM HINGE; શ્ર 1 PER INTERMEDIATE IMPACT 5 KOLBE HINGE). SEE "FRAME LOCK ANCHOR REQUIREMENTS LOCK 26 5/8" TABLE" ON THIS SHEET MAX. MANOR FOR SCREW STRIKE . W. SCHAEFER ENGINEERING CONSULTING, P.A. (CA 6809) 7480 150TH COURT NORTH PALM BEACH GARDENS, FL 33418 PHONE: 561-744-3424 ′ D.L.O. REQUIREMENTS. PLATE SERIES 6" MAX. ULTRA SEE CORNER **EXTERIOR ELEVATION;** CONSTRUCTION DOUBLE RECTANGULAR DOOR DETAILS ON SHEET 6 SCALE: 1/2" = 1'-0"ર્કે ¥ HINGE REQUIREMENTS 2020 (ALL DOOR CONDITIONS) 4 PER PANEL (ALL DOOR SIZES) ALLOWABLE DESIGN PRESSURE (ALL DOOR CONDITIONS) DOOR FRAME HEIGHT POSITIVE NEGATIVE 1830 82.6" OR LESS 70 PSF 70 PSF SHEET NO. TALLER THAN 82.6" 65 PSF | 65 PSF OF

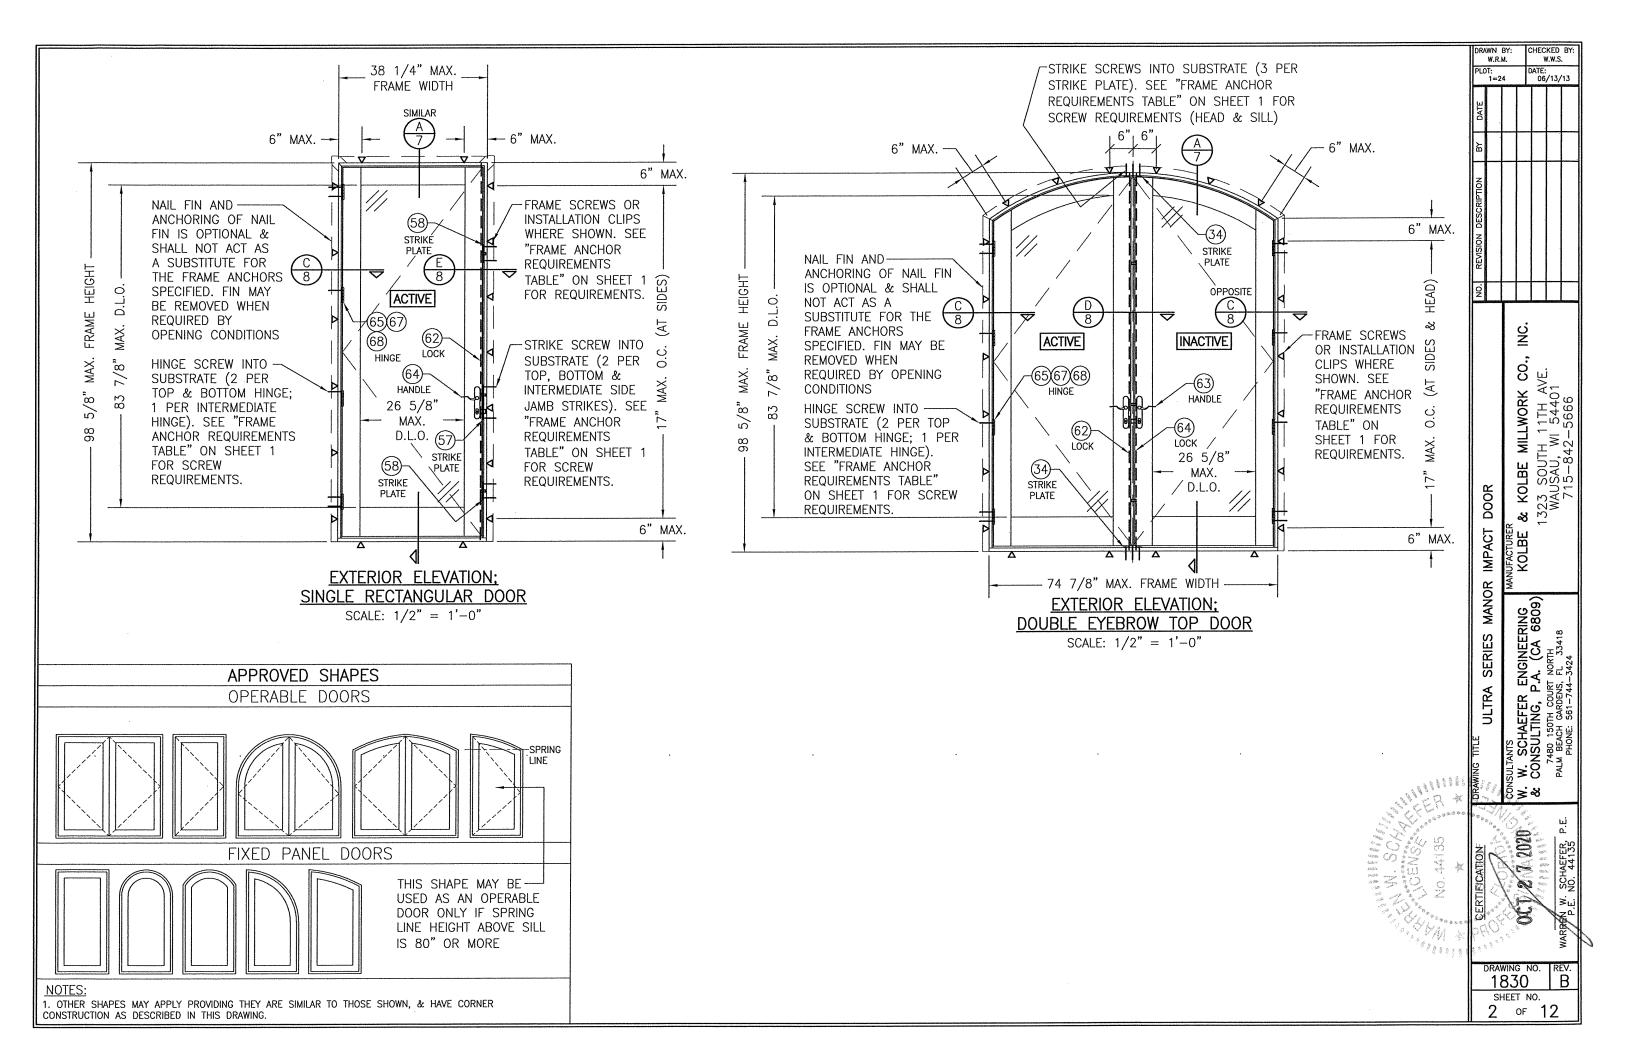

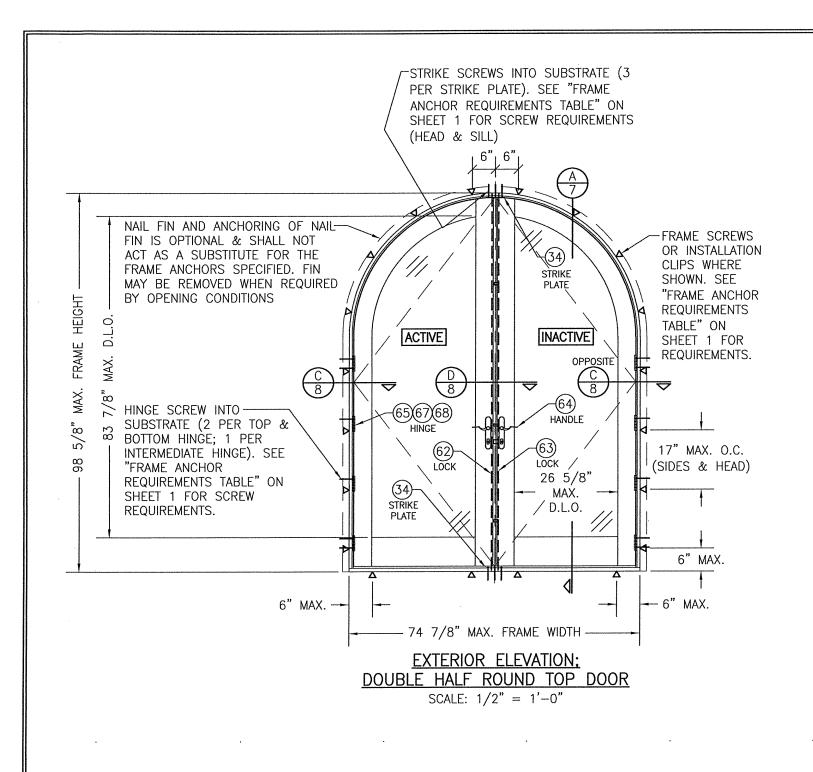

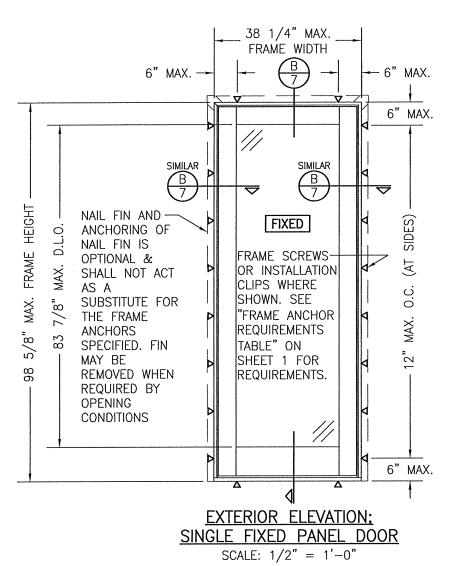

RECTANGULAR FIXED PANEL SHOWN, SHAPED FIXED PANEL UNITS ALSO APPLY PROVIDING THE HEADS OF THOSE UNITS ARE INSTALLED WITH THE SAME ANCHOR SPACING AS SPECIFIED FOR THE SIDES (12" MAX. O.C.)


Š Š 60. MILLWORK KOLBE DOOR શ્ર IMPACT KOLBE MANOR OUTANTS W. SCHAEFER ENGINEERING CONSULTING, P.A. (CA 6809) SERIES ું કે જે

ATE: 06/13/13

CONSTRUCTION DEATH

DRAWING NO. REV 1830 B SHEET NO.

3 of 12

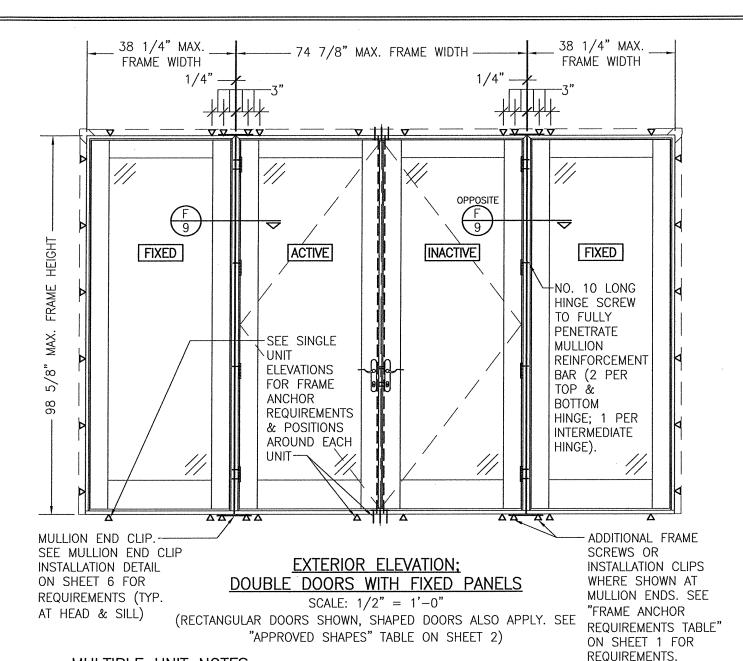


**MULTIPLE UNIT NOTES:** 

1. FOR DETAIL NOT SHOWN, SEE INDIVIDUAL UNIT ELEVATIONS.

2. THERE IS NO LIMIT ON THE NUMBER OF DOORS THAT MAY BE COMBINED IN ONE DIRECTION INTO ONE OPENING PROVIDING THE OPENING IS DESIGNED TO SUPPORT ALL LOADS TRANSFERRED FROM THE DOORS & THEIR MULLIONS.

3. OXXO UNIT IS SHOWN. ALL OTHER FIXED/OPERABLE COMBINATIONS ALSO APPLY WITH THE MULLION CONDITIONS SHOWN.

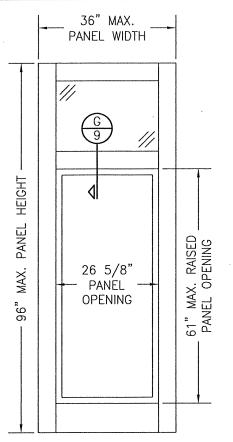

## **EXTERIOR ELEVATION:** RAISED PANEL

SCALE: 1/2" = 1'-0'

RAISED PANEL NOTES:

1. SINGLE RAISED PANEL CONDITION SHOWN, MORE THAN ONE RAISED PANEL MAY EXIST IN A SINGLE DOOR PANEL WHEN MULTIPLE MID-RAILS ARE USED. 2. PANEL ONLY IS SHOWN. FOR INSTALLATION INTO

FRAME, SEE OTHER ELEVATIONS. 3. THESE PANEL CONDITIONS APPLY WITH BOTH

OPERABLE & FIXED PANEL DOORS 4. RECTANGULAR CONDITION SHOWN, SHAPED


CONDITIONS ALSO APPLY. 5. VERTICAL MID-RAILS MAY BE USED BETWEEN HORIZONTAL MID-RAILS AT RAISED PANEL PROVIDING RAIL SPAN DOES NOT EXCEED 26 5/8".


Š. 89 MILLWORK KOLBE DOOR શ્ર IMPACT KOLBE MANOR W. SCHAEFER ENGINEERING
CONSULTING, P.A. (CA 6809)
7480 150TH COURT NORTH
PALM BEACH CARDENS, FL. 33418 SERIES ULTRA ટ્રે ≯.જ


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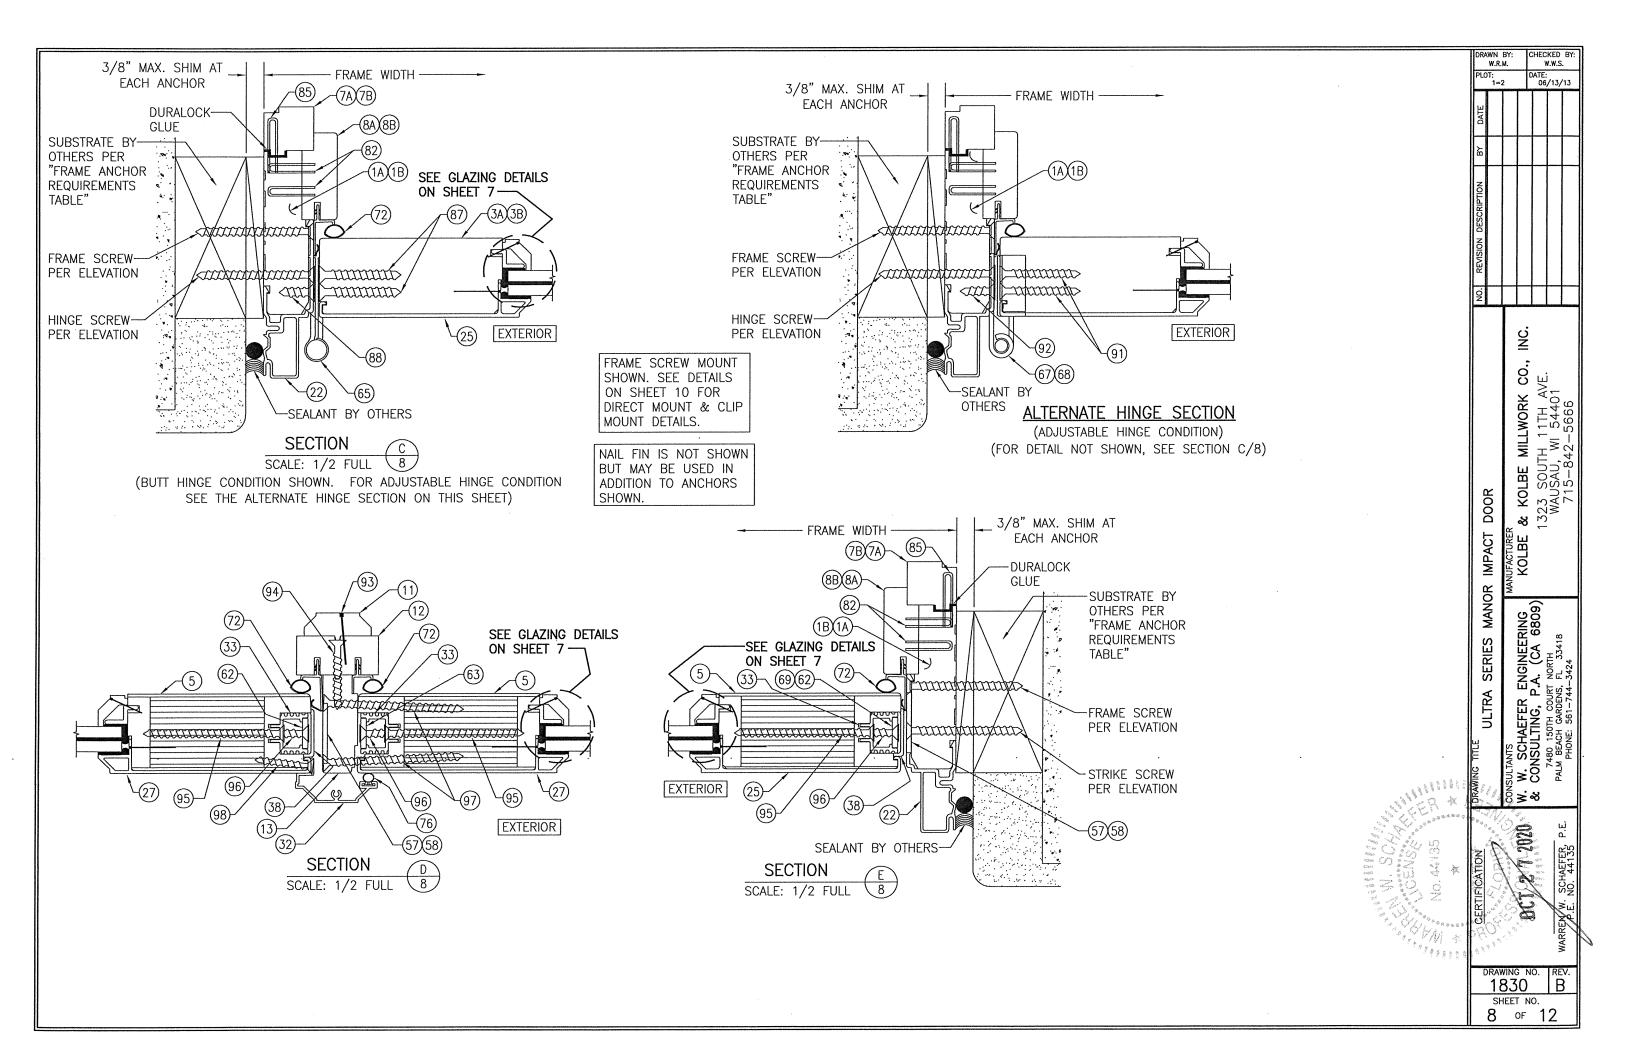
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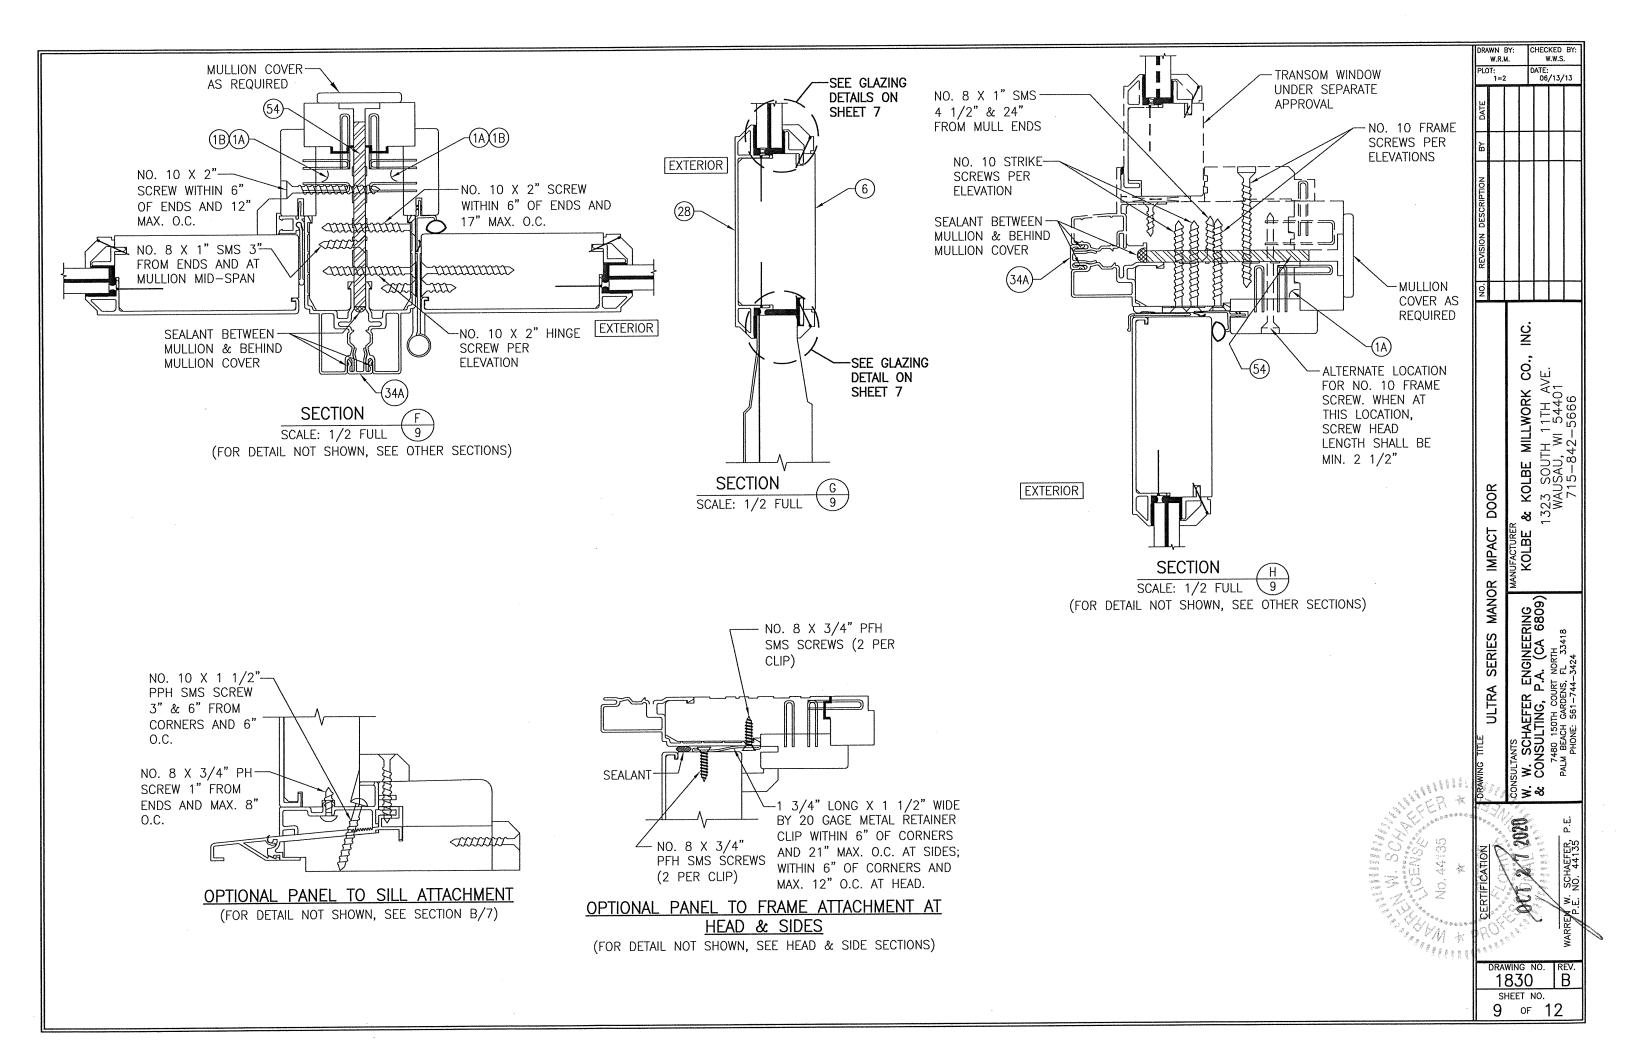
SHEET NO. of 12







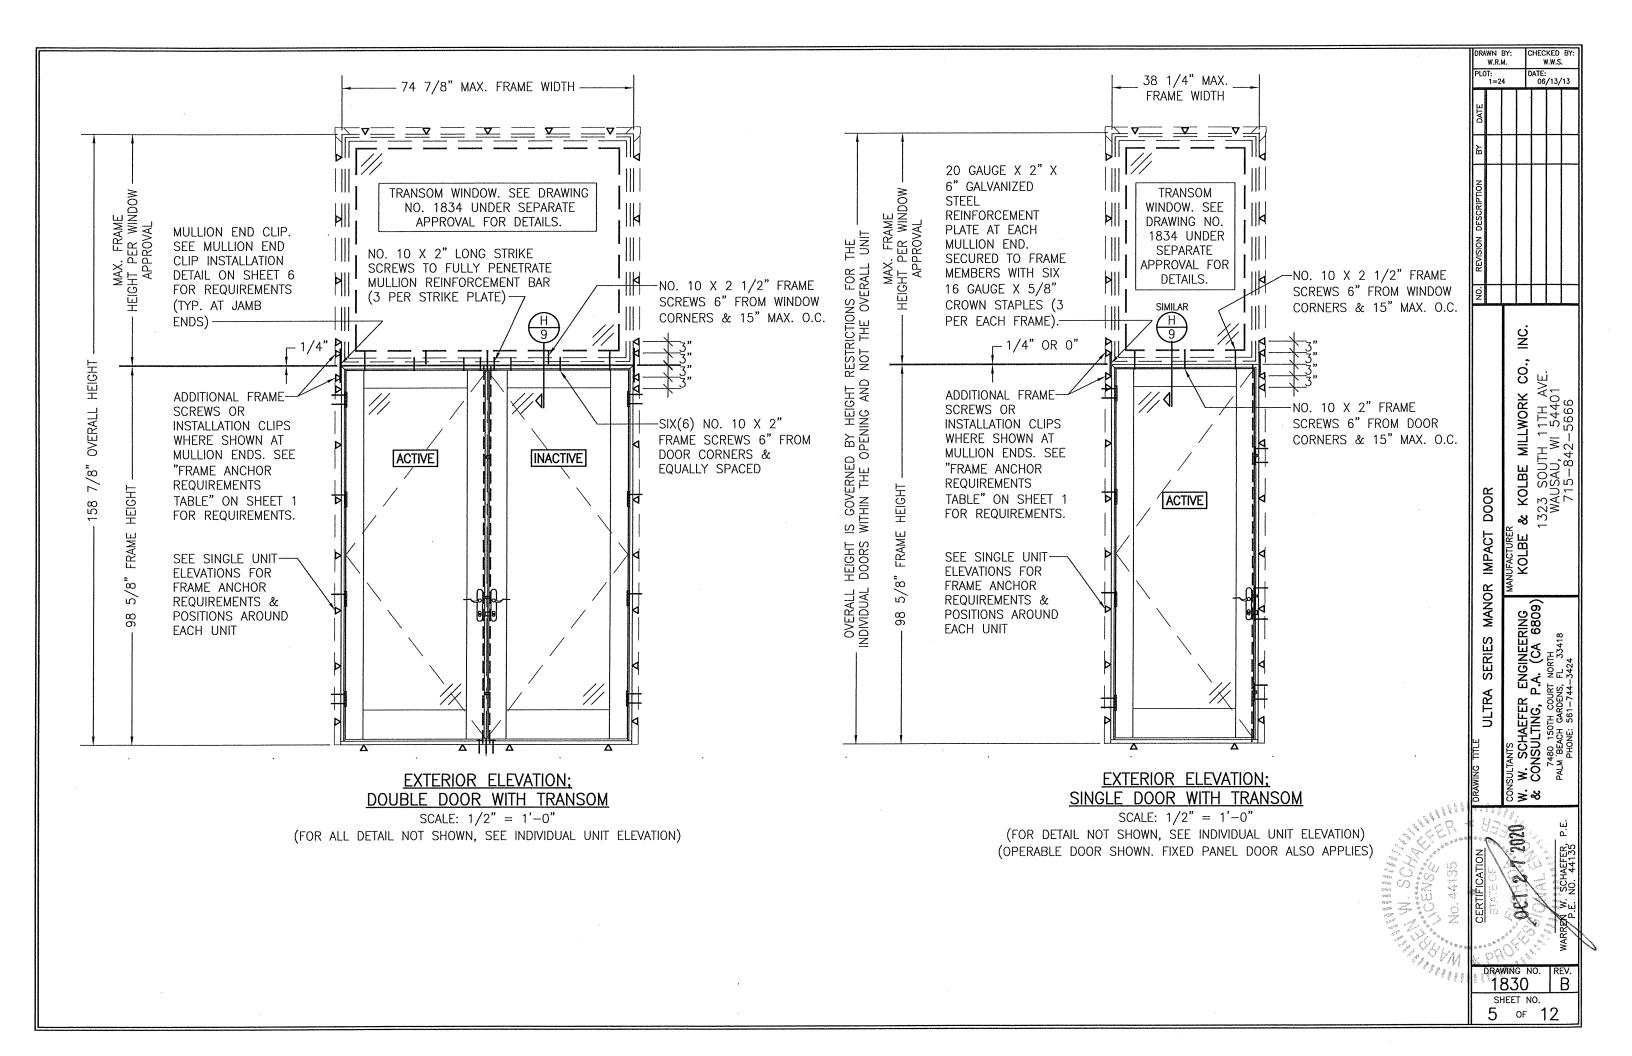

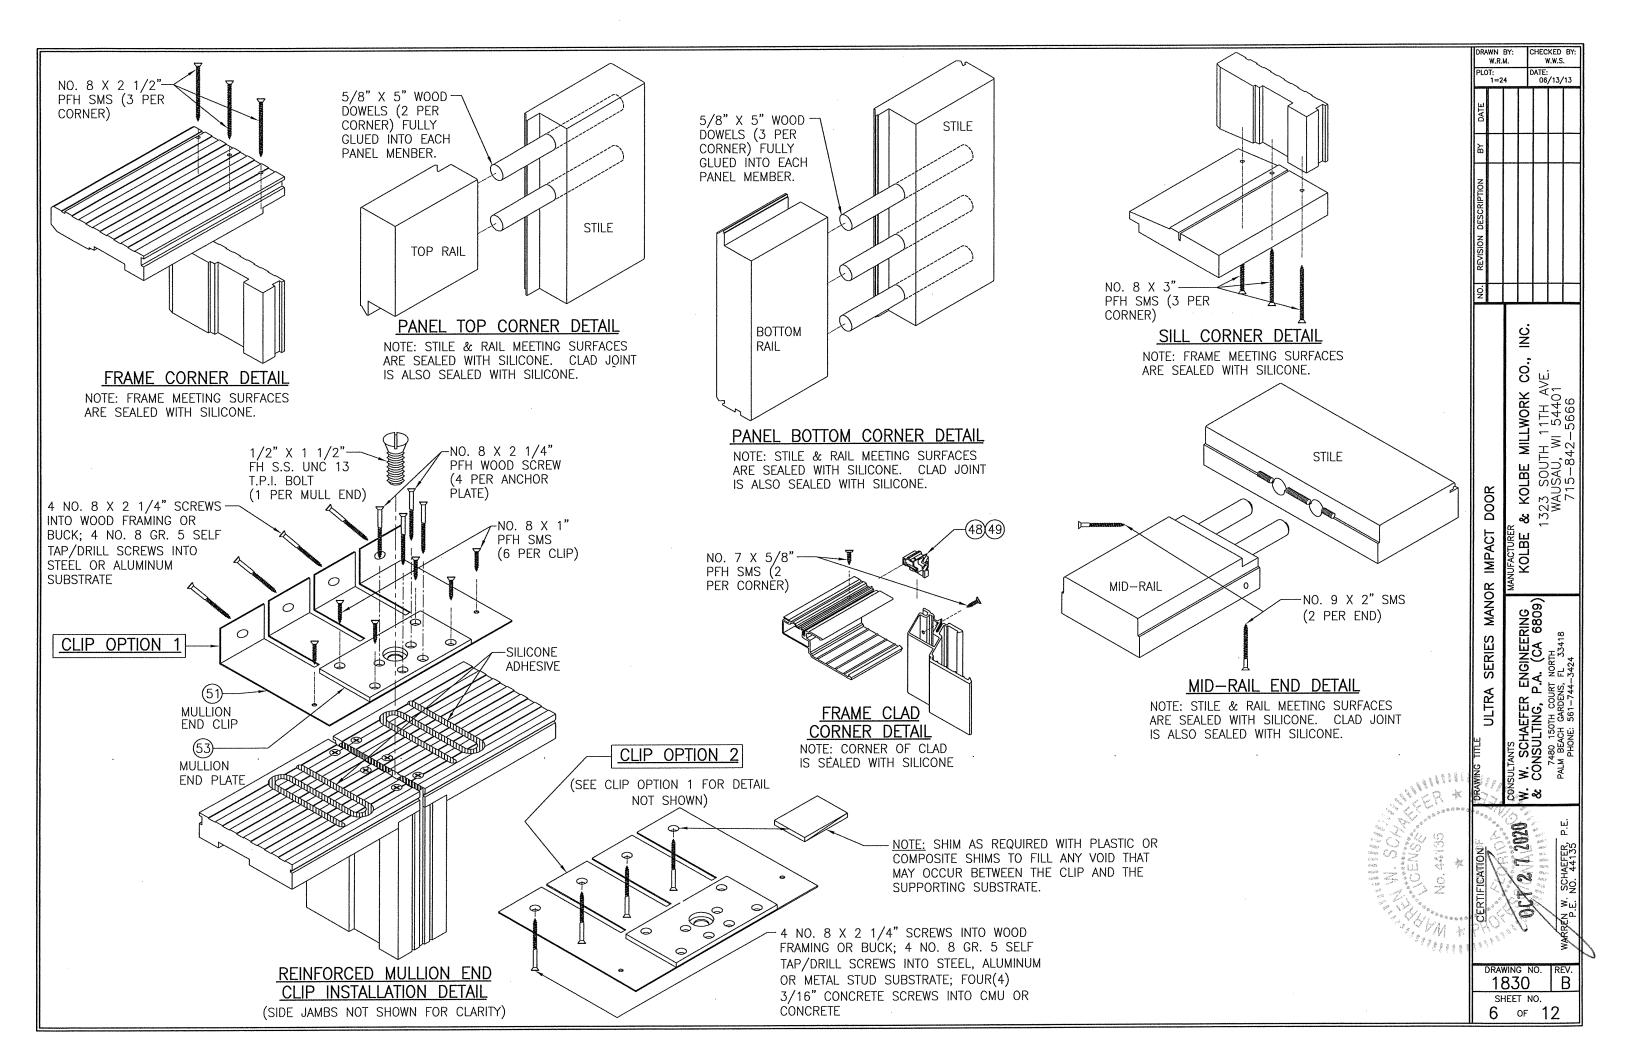

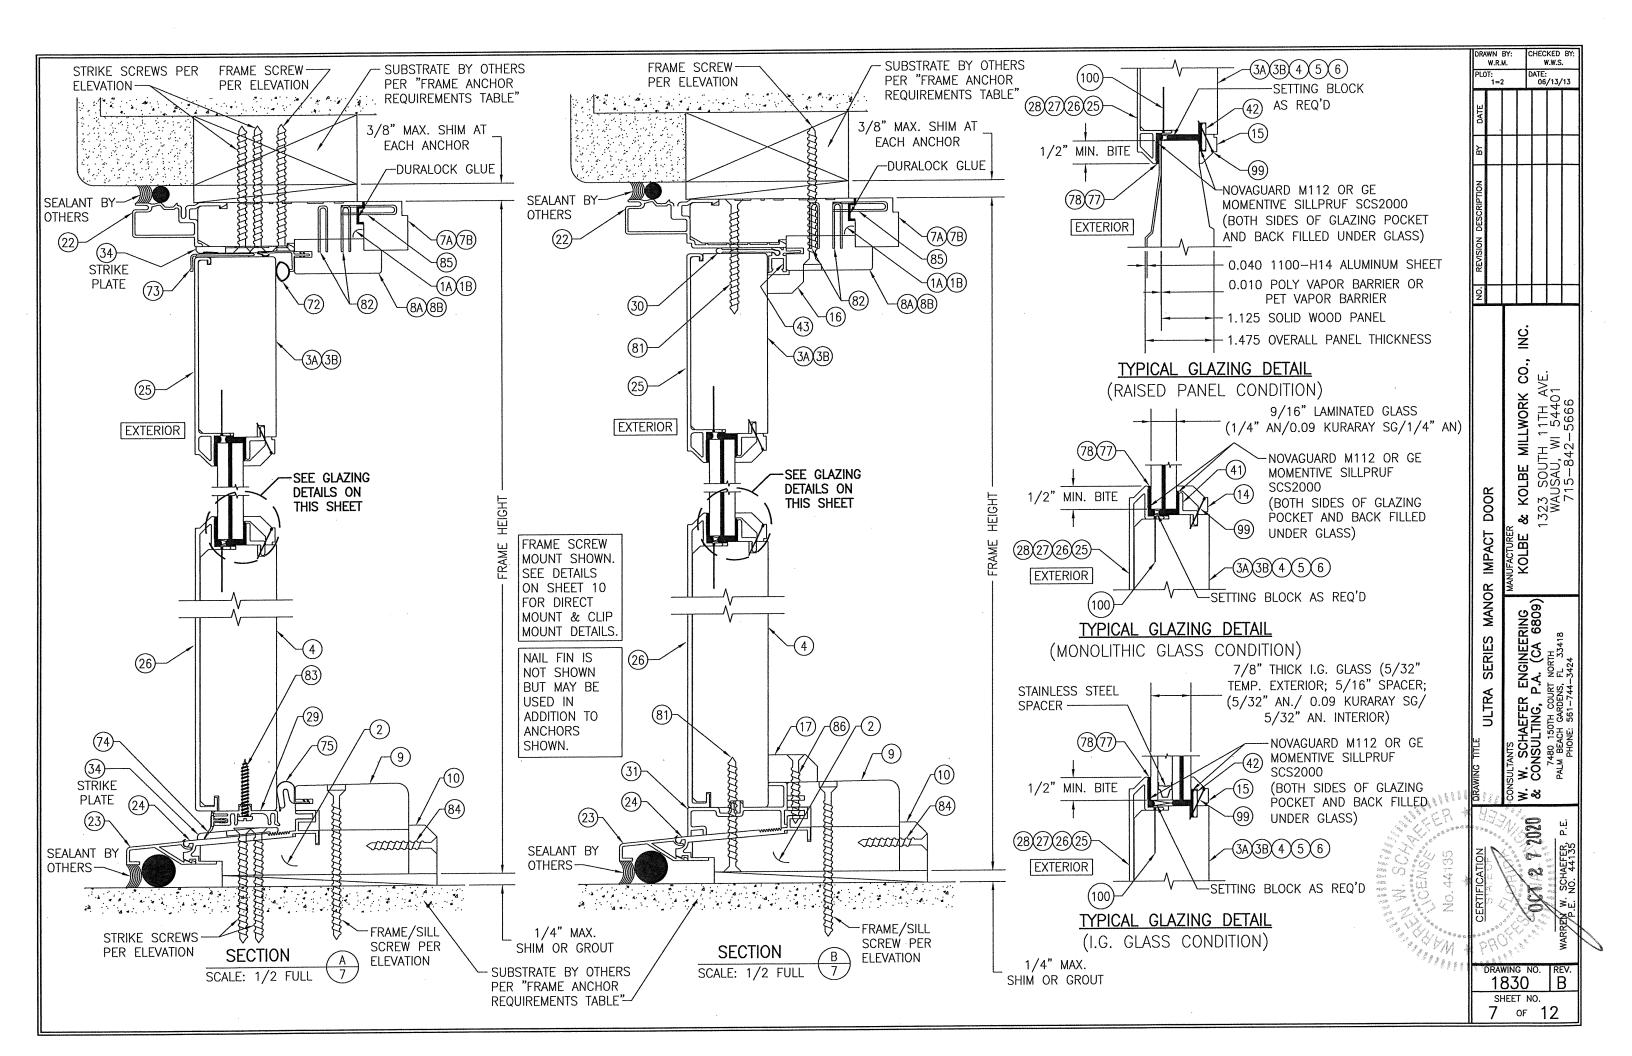

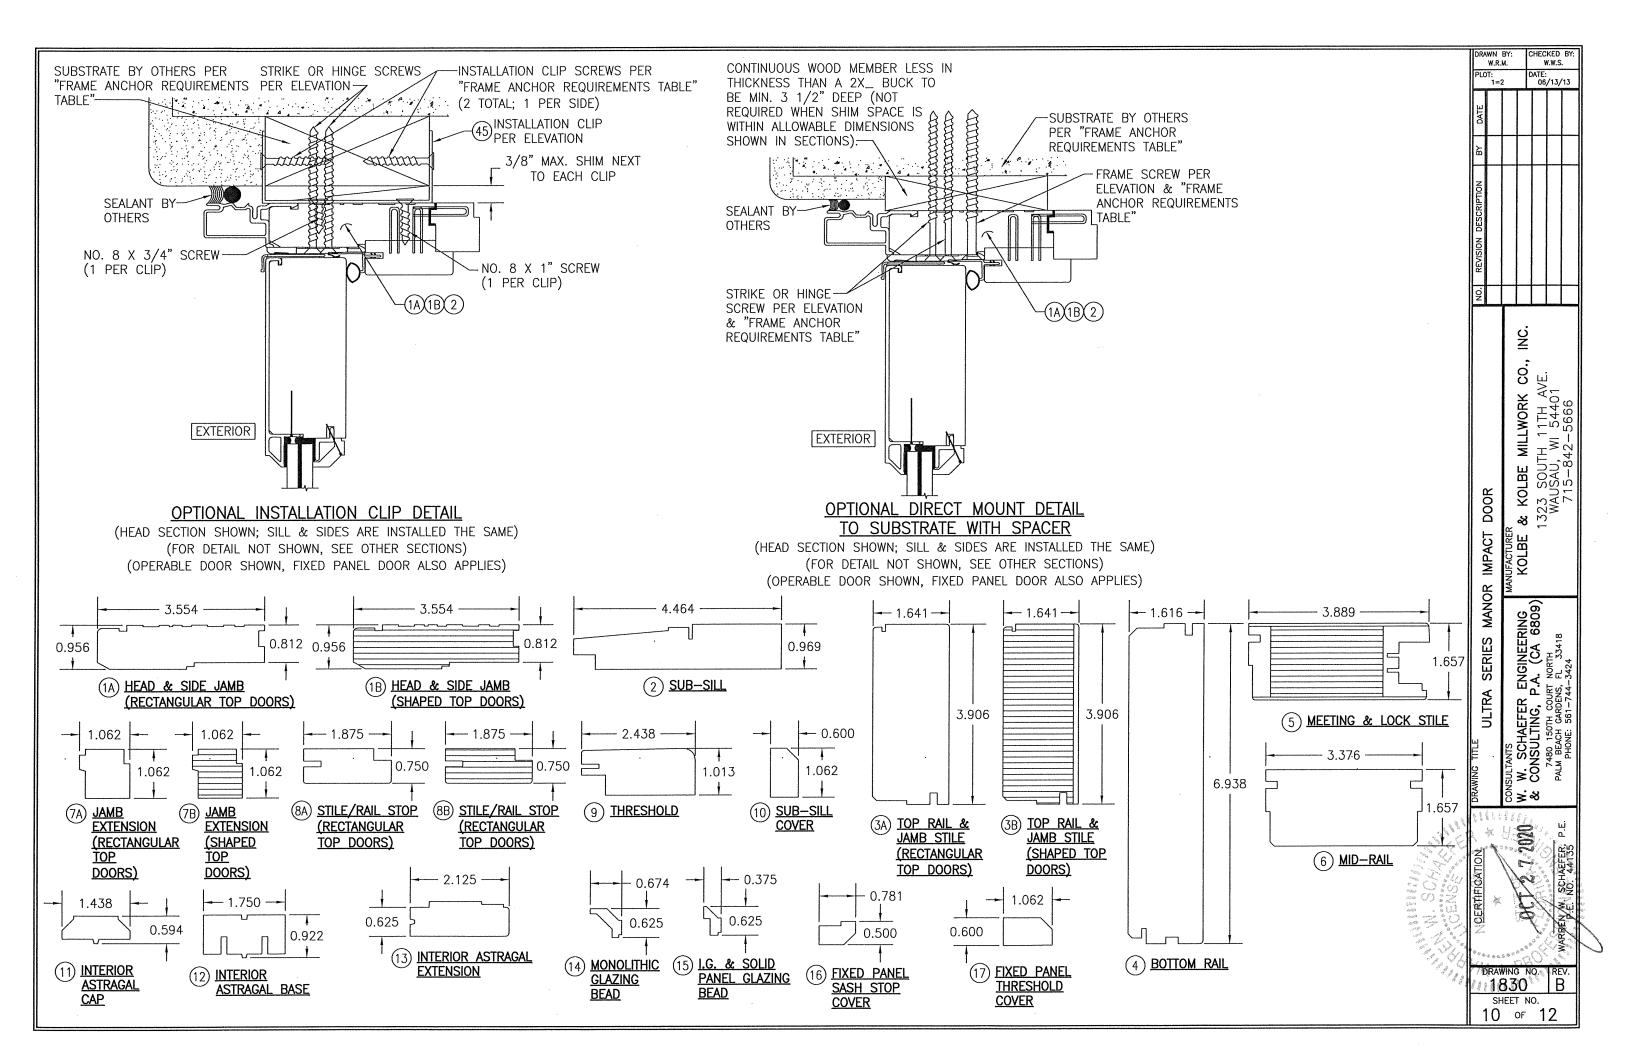

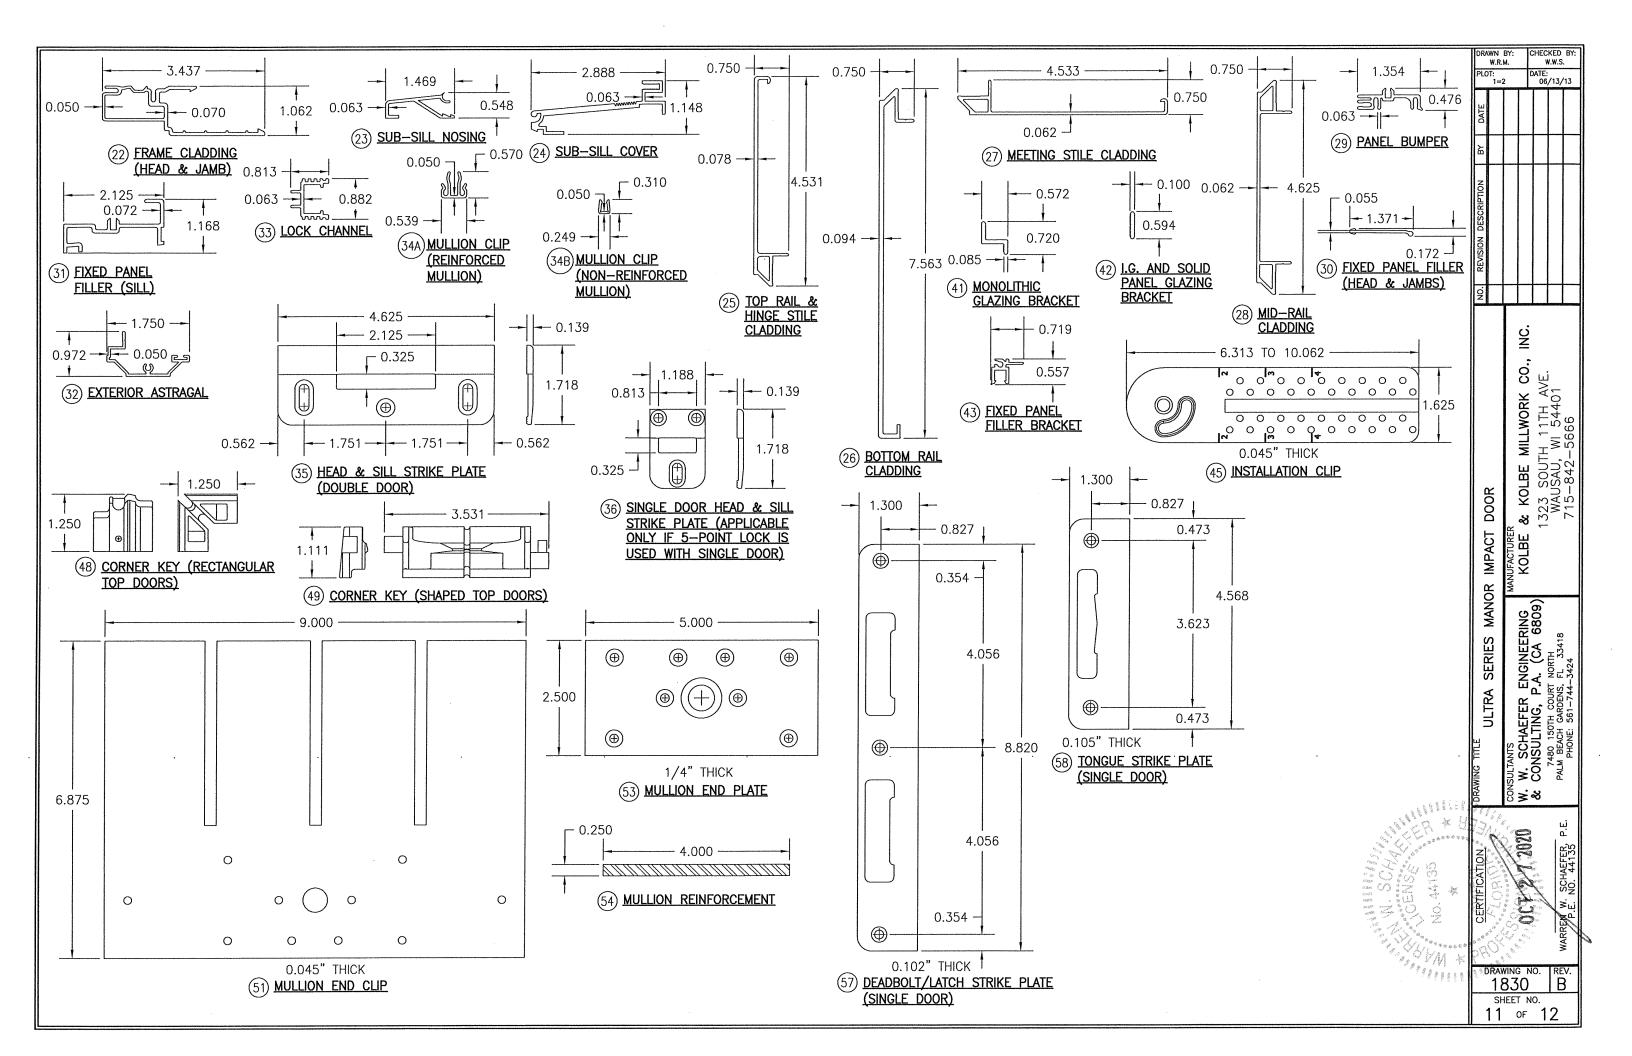

ITEM #	ITEM DESCRIPTION	MANUFACTURER/NOTES	
٦	PARTS	Turon	<del>                                     </del>
1A	HEAD & SIDE JAMB (RECTANGULAR TOP DOORS)	WOOD	┦
1B	HEAD & SIDE JAMB (SHAPED TOP DOORS)	LVL	┨
2	SUB-SILL	WOOD	
3A	TOP RAIL & JAMB STILE (RECTANGULAR TOP DOORS)	WOOD	
3B	TOP RAIL & JAMB STILE (SHAPED TOP DOORS)	LVL	┨
4	BOTTOM RAIL	WOOD	1
5	MEETING & LOCK STILE	LVL CORE WITH WOOD VENEER	1
6	MID-RAIL	WOOD	┨┝──
7A 7B	JAMB EXTENSION (RECTANGULAR TOP DOORS)  JAMB EXTENSION (SHAPED TOP DOORS)	WOOD LVL	┨┝━
	STILE/RAIL STOP (RECTANGULAR TOP DOORS)	WOOD	┨├─
8B	STILE/RAIL STOP (SHAPED TOP DOORS)	LVL WITH WOOD VENEER	┨┝━
9	THRESHOLD	WOOD VENEER	┨├─
10	SUB-SILL COVER	WOOD	┨┣━
	INTERIOR ASTRAGAL CAP		┨┝─
		WOOD	┨┝─
	INTERIOR ASTRAGAL BASE INTERIOR ASTRAGAL EXTENSION	WOOD	+
			┨├─
	MONOLITHIC GLAZING BEAD  I.G. & SOLID PANEL GLAZING BEAD	WOOD	1
16	FIXED PANEL SASH STOP COVER	WOOD	+
		WOOD	┨┝╴
17 22	FIXED PANEL THRESHOLD COVER FRAME CLADDING		$+\vdash$
	SUB-SILL NOSING	6063-T5 ALUMINUM 6063-T5 ALUMINUM	+
	SUB-SILL ROSING SUB-SILL COVER		+
24 25	TOP RAIL & HINGE STILE CLADDING	6063-T5 ALUMINUM 6063-T5 ALUMINUM	┨┝
26	BOTTOM RAIL CLADDING	6063-T5 ALUMINUM	+1
27	MEETING STILE CLADDING	6063-T5 ALUMINUM	┨┝
28	MID—RAIL CLADDING	6063—T5 ALUMINUM	┨.
	PANEL BUMPER	6063-T5 ALUMINUM	$\dagger$
	FIXED PANEL FILLER (HEAD & JAMBS)	6063—T5 ALUMINUM	11
	FIXED PANEL FILLER (SILL)	6063—T5 ALUMINUM	1
	EXTERIOR ASTRAGAL	6063-T5 ALUMINUM	1
	LOCK CHANNEL	6063-T5 ALUMINUM	┨┠─
	MULLION CLIP (REINFORCED MULLION)	6063-T5 ALUMINUM	┧├─
	MULLION CLIP (NON-REINFORCED MULLION)	6063-T5 ALUMINUM	1
	HEAD & SILL STRIKE PLATE (DOUBLE DOOR)	6105-T5 ALUMINUM	1 -
	SINGLE DOOR HEAD & SILL STRIKE PLATE	6105-T5 ALUMINUM	1
	(APPLICABLE ONLY IF 5—POINT LOCK IS USED	TO TO ALCHINYOM	
į	WITH SINGLE DOOR)		.
	7" LONG S.S. LOCK STILE U-CHANNEL	18-8 S.S. (TOP & BOTTOM OF LOCK STILE)	1
	MONOLITHIC GLAZING BRACKET (DUROMETER = 70)	PRESTIGE PLASTICS RIGID PVC	1
1	I.G. AND SOLID PANEL GLAZING BRACKET	PRESTIGE PLASTICS RIGID PVC	1
1	(DUROMETER = 70)	, , , , , , , , , , , , , , , , , , , ,	
	FIXED PANEL FILLER BRACKET	CLIM-A-TECH RIGID & FLEXABLE PVC	1
	INSTALLATION CLIP	ASTM A653 MIN. 33 KSI GALV. STEEL	1
	CORNER KEY (RECTANGULAR TOP DOORS)	DARTER PLASTICS POLYCARBONATE	1
	CORNER KEY (SHAPED TOP DOORS)	DARTER PLASTICS POLYCARBONATE	1
	MULLION END CLIP	ASTM A653 GALV. STEEL (Fy = 50 ksi)	1
	MULLION END PLATE	A-36 STEEL	1
	MULLION REINFORCEMENT	A-36 STEEL	1
	DEADBOLT/LATCH STRIKE PLATE (SINGLE DOORS)	S.S., BRASS OR BRONZE	1
	TONGUE STRIKE PLATE (SINGLE DOORS)	S.S., BRASS OR BRONZE	1
	WOOD USED IN TESTING WAS PINE WITH A SPECIFIC GR		TICIT
	OF E = $1,200,000$ PSI. ALL WOOD IS MINIMUM GRAI		.,51

POINT LOCK HARDWARE (ACTIVE PANEL) POINT LOCK HARDWARE (INACTIVE PANEL)  IANDLE  X4 BUTT HINGE WITH STATIONARY PIN  X4 ADJUSTABLE SET (INTERMEDIATE) HINGE  X4 ADJUSTABLE GUIDE (TOP & BOTTOM) HINGE  SEALS & SEALANTS  BULB/FIN WEATHERSTRIP  IN WEATHERSTRIP  XTERIOR PANEL WEATHERSTRIP  BULB WEATHERSTRIP  BULB WEATHERSTRIP  BULB WEATHERSTRIP  BULB WEATHERSTRIP  BULB MEATHERSTRIP  BULB MEATHERST	HARDWARE  HTL HLS-9000 SERIES  HTL HLS-9000 SERIES  AS REQUIRED TO OPERATE LOCK SYSTEM  HAGER 5060390 S.S., STEEL, BRASS OR BRONZE  HTL 5143790 S.S., STEEL, BRASS OR BRONZE  HTL 5143780 S.S., STEEL, BRASS OR BRONZE  HTL 5143780 S.S., STEEL, BRASS OR BRONZE  INTEK 5074565 POLYPROPELENE/SANTOPRENE  CLIM-A-TECH 5095675 RIGID & FLEXABLE PVC  AMESBURY GROUP 5031500 RIGID & FLEXABLE PVC  AMESBURY GROUP 5146560 POLYPROPELENE/SANTOPRENE  AMESBURY GROUP 5066980 POLYPROPELENE  80 DUROMETER EPDM WITHIN 1" OF ENDS & 8" MAX. O.C.	NO. REVISION DESCRIPTION BY DATE	2 D	ATE: 06/13/1
POINT LOCK HARDWARE (ACTIVE PANEL) POINT LOCK HARDWARE (INACTIVE PANEL)  IANDLE  X4 BUTT HINGE WITH STATIONARY PIN  X4 ADJUSTABLE SET (INTERMEDIATE) HINGE  X4 ADJUSTABLE GUIDE (TOP & BOTTOM) HINGE  SEALS & SEALANTS  BULB/FIN WEATHERSTRIP  IN WEATHERSTRIP  XTERIOR PANEL WEATHERSTRIP  BULB WEATHERSTRIP  BULB WEATHERSTRIP  BULB WEATHERSTRIP  BULB WEATHERSTRIP  BULB MEATHERSTRIP  BULB MEATHERST	HTL HLS-9000 SERIES  HTL HLS-9000 SERIES  AS REQUIRED TO OPERATE LOCK SYSTEM  HAGER 5060390 S.S., STEEL, BRASS OR BRONZE  HTL 5143790 S.S., STEEL, BRASS OR BRONZE  HTL 5143780 S.S., STEEL, BRASS OR BRONZE  INTEK 5074565 POLYPROPELENE/SANTOPRENE  CLIM-A-TECH 5095675 RIGID & FLEXABLE PVC  AMESBURY GROUP 5031500 RIGID & FLEXABLE PVC  AMESBURY GROUP 5146560 POLYPROPELENE/SANTOPRENE  AMESBURY GROUP 5066980 POLYPROPELENE  80 DUROMETER EPDM WITHIN 1" OF ENDS & 8" MAX. O.C.	REVISION DESCRIPTION		
I—POINT LOCK HARDWARE (INACTIVE PANEL) IANDLE  X4 BUTT HINGE WITH STATIONARY PIN  X4 ADJUSTABLE SET (INTERMEDIATE) HINGE  X4 ADJUSTABLE GUIDE (TOP & BOTTOM) HINGE  SEALS & SEALANTS  BULB/FIN WEATHERSTRIP  IN WEATHERSTRIP  XTERIOR PANEL WEATHERSTRIP  BULB WEATHERSTRIP  BULB WEATHERSTRIP  BULB WEATHERSTRIP  BULB WEATHERSTRIP  BULB WEATHERSTRIP  BULB T/16" X 1/4" X 1/2"  BULB LAZING TAPE 1/16" X 1/4"	HTL HLS-9000 SERIES  AS REQUIRED TO OPERATE LOCK SYSTEM  HAGER 5060390 S.S., STEEL, BRASS OR BRONZE  HTL 5143790 S.S., STEEL, BRASS OR BRONZE  HTL 5143780 S.S., STEEL, BRASS OR BRONZE  INTEK 5074565 POLYPROPELENE/SANTOPRENE  CLIM-A-TECH 5095675 RIGID & FLEXABLE PVC  AMESBURY GROUP 5031500 RIGID & FLEXABLE PVC  AMESBURY GROUP 5146560 POLYPROPELENE/SANTOPRENE  AMESBURY GROUP 5066980 POLYPROPELENE  80 DUROMETER EPDM WITHIN 1" OF ENDS & 8" MAX. O.C.	REVISION DESCRIPTION		
IANDLE  X4 BUTT HINGE WITH STATIONARY PIN  X4 ADJUSTABLE SET (INTERMEDIATE) HINGE  X4 ADJUSTABLE GUIDE (TOP & BOTTOM) HINGE  SEALS & SEALANTS  BULB/FIN WEATHERSTRIP  IN WEATHERSTRIP  IXTERIOR PANEL WEATHERSTRIP  BULB WEATHERSTRIP  BULB WEATHERSTRIP  BULB WEATHERSTRIP  BULB WEATHERSTRIP  BULB WEATHERSTRIP  BULB T/16" X 1/4" X 1/2"  BULB WEATHERSTRIP  BUL	AS REQUIRED TO OPERATE LOCK SYSTEM  HAGER 5060390 S.S., STEEL, BRASS OR BRONZE  HTL 5143790 S.S., STEEL, BRASS OR BRONZE  HTL 5143780 S.S., STEEL, BRASS OR BRONZE  INTEK 5074565 POLYPROPELENE/SANTOPRENE  CLIM—A—TECH 5095675 RIGID & FLEXABLE PVC  AMESBURY GROUP 5031500 RIGID & FLEXABLE PVC  AMESBURY GROUP 5146560 POLYPROPELENE/SANTOPRENE  AMESBURY GROUP 5066980 POLYPROPELENE  80 DUROMETER EPDM WITHIN 1" OF ENDS & 8" MAX. O.C.	REVISION DESCRIPTION		
X4 BUTT HINGE WITH STATIONARY PIN X4 ADJUSTABLE SET (INTERMEDIATE) HINGE X4 ADJUSTABLE GUIDE (TOP & BOTTOM) HINGE SEALS & SEALANTS BULB/FIN WEATHERSTRIP IN WEATHERSTRIP XTERIOR PANEL WEATHERSTRIP BULB WEATHERSTRIP BULB WEATHERSTRIP BULB WEATHERSTRIP BULB TAY 1/4" X 1/2" BULB STATE	HAGER 5060390 S.S., STEEL, BRASS OR BRONZE HTL 5143790 S.S., STEEL, BRASS OR BRONZE HTL 5143780 S.S., STEEL, BRASS OR BRONZE  INTEK 5074565 POLYPROPELENE/SANTOPRENE CLIM-A-TECH 5095675 RIGID & FLEXABLE PVC AMESBURY GROUP 5031500 RIGID & FLEXABLE PVC AMESBURY GROUP 5146560 POLYPROPELENE/SANTOPRENE AMESBURY GROUP 5066980 POLYPROPELENE 80 DUROMETER EPDM WITHIN 1" OF ENDS & 8" MAX. O.C.	REVISION DESCRIPTION		
X4 ADJUSTABLE SET (INTERMEDIATE) HINGE X4 ADJUSTABLE GUIDE (TOP & BOTTOM) HINGE SEALS & SEALANTS BULB/FIN WEATHERSTRIP IN WEATHERSTRIP EXTERIOR PANEL WEATHERSTRIP BULB WEATHERSTRIP BULB WEATHERSTRIP BULB WEATHERSTRIP BULB WEATHERSTRIP BULB T/16" X 1/4" X 1/2" BULB SEALANTS BULB WEATHERSTRIP BULB WEATHERSTRIP BULB T/16" X 1/4" X 1/2" BULB WEATHERSTRIP	HTL 5143790 S.S., STEEL, BRASS OR BRONZE  HTL 5143780 S.S., STEEL, BRASS OR BRONZE  INTEK 5074565 POLYPROPELENE/SANTOPRENE  CLIM—A—TECH 5095675 RIGID & FLEXABLE PVC  AMESBURY GROUP 5031500 RIGID & FLEXABLE PVC  AMESBURY GROUP 5146560 POLYPROPELENE/SANTOPRENE  AMESBURY GROUP 5066980 POLYPROPELENE  80 DUROMETER EPDM WITHIN 1" OF ENDS & 8" MAX. O.C.	1		
X4 ADJUSTABLE GUIDE (TOP & BOTTOM) HINGE SEALS & SEALANTS BULB/FIN WEATHERSTRIP IN WEATHERSTRIP EXTERIOR PANEL WEATHERSTRIP BULB WEATHERSTRIP BULB WEATHERSTRIP BULB WEATHERSTRIP BULB WEATHERSTRIP BULB MEATHERSTRIP BULB MEATHERST	HTL 5143780 S.S., STEEL, BRASS OR BRONZE  INTEK 5074565 POLYPROPELENE/SANTOPRENE  CLIM—A—TECH 5095675 RIGID & FLEXABLE PVC  AMESBURY GROUP 5031500 RIGID & FLEXABLE PVC  AMESBURY GROUP 5146560 POLYPROPELENE/SANTOPRENE  AMESBURY GROUP 5066980 POLYPROPELENE  80 DUROMETER EPDM WITHIN 1" OF ENDS & 8" MAX. O.C.	1		
SEALS & SEALANTS BULB/FIN WEATHERSTRIP IN WEATHERSTRIP XTERIOR PANEL WEATHERSTRIP BULB WEATHERSTRIP BULB WEATHERSTRIP BHIM 1/16" X 1/4" X 1/2" BLAZING TAPE 1/16" X 1/4"	INTEK 5074565 POLYPROPELENE/SANTOPRENE  CLIM-A-TECH 5095675 RIGID & FLEXABLE PVC  AMESBURY GROUP 5031500 RIGID & FLEXABLE PVC  AMESBURY GROUP 5146560 POLYPROPELENE/SANTOPRENE  AMESBURY GROUP 5066980 POLYPROPELENE  80 DUROMETER EPDM WITHIN 1" OF ENDS & 8" MAX. O.C.	1		
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·	& ONE(1) AT PANEL MIDSPAN)		8	بنا
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O. 6 X 1 1/4" SELF TAPPING SCREW			臣	۲. کر این کری کر این کر این کر کر این کر کر کر این کر کر کر این کر
8 GAUGE X 3/4" BRAD NAIL			¥ F	= ES X
5 GAUGE X 1" BRAD NAIL	WITHIN 2" FROM CORNERS & MAX. 8" O.C.		Ε̈Ϋ́,	7480 15 PALM BEACH
	/8" X 1" 18 GAUGE STAPLE  0. 8 X 1 1/4" PPH SMS  0. 8 X 1 1/4" PPH SMS  /8" X 1 1/4" 18 GAUGE STAPLE  0. 8 X 1 1/4" PFH SMS  0. 12 X 1 3/4" PFH  RASS OR S.S. WOOD SCREW  0. 12 X 3/4" PFH BRASS OR S.S. SMS  0. 9 X 1 3/4" PFH  RASS OR S.S. WOOD SCREW  0. 9 X 3/4" PFH BRASS OR S.S. SMS  /8" X 1" 18 GAUGE STAPLE  0. 8 X 1 3/4" SMS  0.10 X 3" PFH SMS  0. 10 X 3" PFH SMS  0. 8 X 3" PFH SMS  0. 6 X 1 1/4" SELF TAPPING SCREW	& ONE(1) AT PANEL MIDSPAN)  /8" X 1" 18 GAUGE STAPLE  WITHIN 2" FROM ENDS & MAX. 8" O.C.  0. 8 X 1 1/4" PPH SMS  WITHIN 1" FROM ENDS & MAX. 8" O.C.  WITHIN 2" FROM ENDS & MAX. 8" O.C.  WITHIN 2" FROM ENDS & MAX. 14" O.C.  WITHIN 2" FROM ENDS & MAX. 14" O.C.  WITHIN 2" FROM ENDS & MAX. 14" O.C.  WITHIN 2" FROM CORNERS & MAX. 8" O.C.  D. 12 X 1 3/4" PFH SMS  WITHIN 4" FROM CORNERS & MAX. 13 1/2" O.C.  WITHIN 4" FROM CORNERS & MAX. 13 1/2" O.C.  D. 12 X 3/4" PFH BRASS OR S.S. SMS  PER INTERMEDIATE HINGE  D. 9 X 1 3/4" PFH BRASS OR S.S. SMS  PER INTERMEDIATE HINGE  D. 9 X 3/4" PFH BRASS OR S.S. SMS  PER INTERMEDIATE HINGE  WITHIN 1/2" FROM ENDS & MAX. 8" O.C.  WITHIN 1/2" FROM ENDS & MAX. 8" O.C.  D. 10 X 3" PFH SMS  PER CHANNEL SPACED ALONG STILE  D. 10 X 3" PFH SMS  PER TOP & 1 PER BOTTOM U-CHANNEL  D. 8 X 3" PFH SMS  PER TOP & 1 PER BOTTOM U-CHANNEL  D. 8 X 3" PFH SMS (2 ROWS)  WITHIN 2" FROM ENDS & MAX. 8" O.C.  WITHIN 2" FROM ENDS & MAX. 12" O.C.  D. 6 X 1 1/4" SELF TAPPING SCREW  WITHIN 2" FROM ENDS & MAX. 8" O.C.  WITHIN 2" FROM ENDS & MAX. 8" O.C.  WITHIN 2" FROM ENDS & MAX. 12" O.C.  D. 6 X 1 1/4" SELF TAPPING SCREW  WITHIN 2" FROM ENDS & MAX. 8" O.C.  WITHIN 1" FROM CORNERS & MAX. 8" O.C.	& ONE(1) AT PANEL MIDSPAN)   /8" X 1" 18 GAUGE STAPLE   WITHIN 2" FROM ENDS & MAX. 8" O.C.	WITHIN 2" FROM ENDS & MAX. 8" O.C.

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